



SECTION C-C  
SCALE 1:50

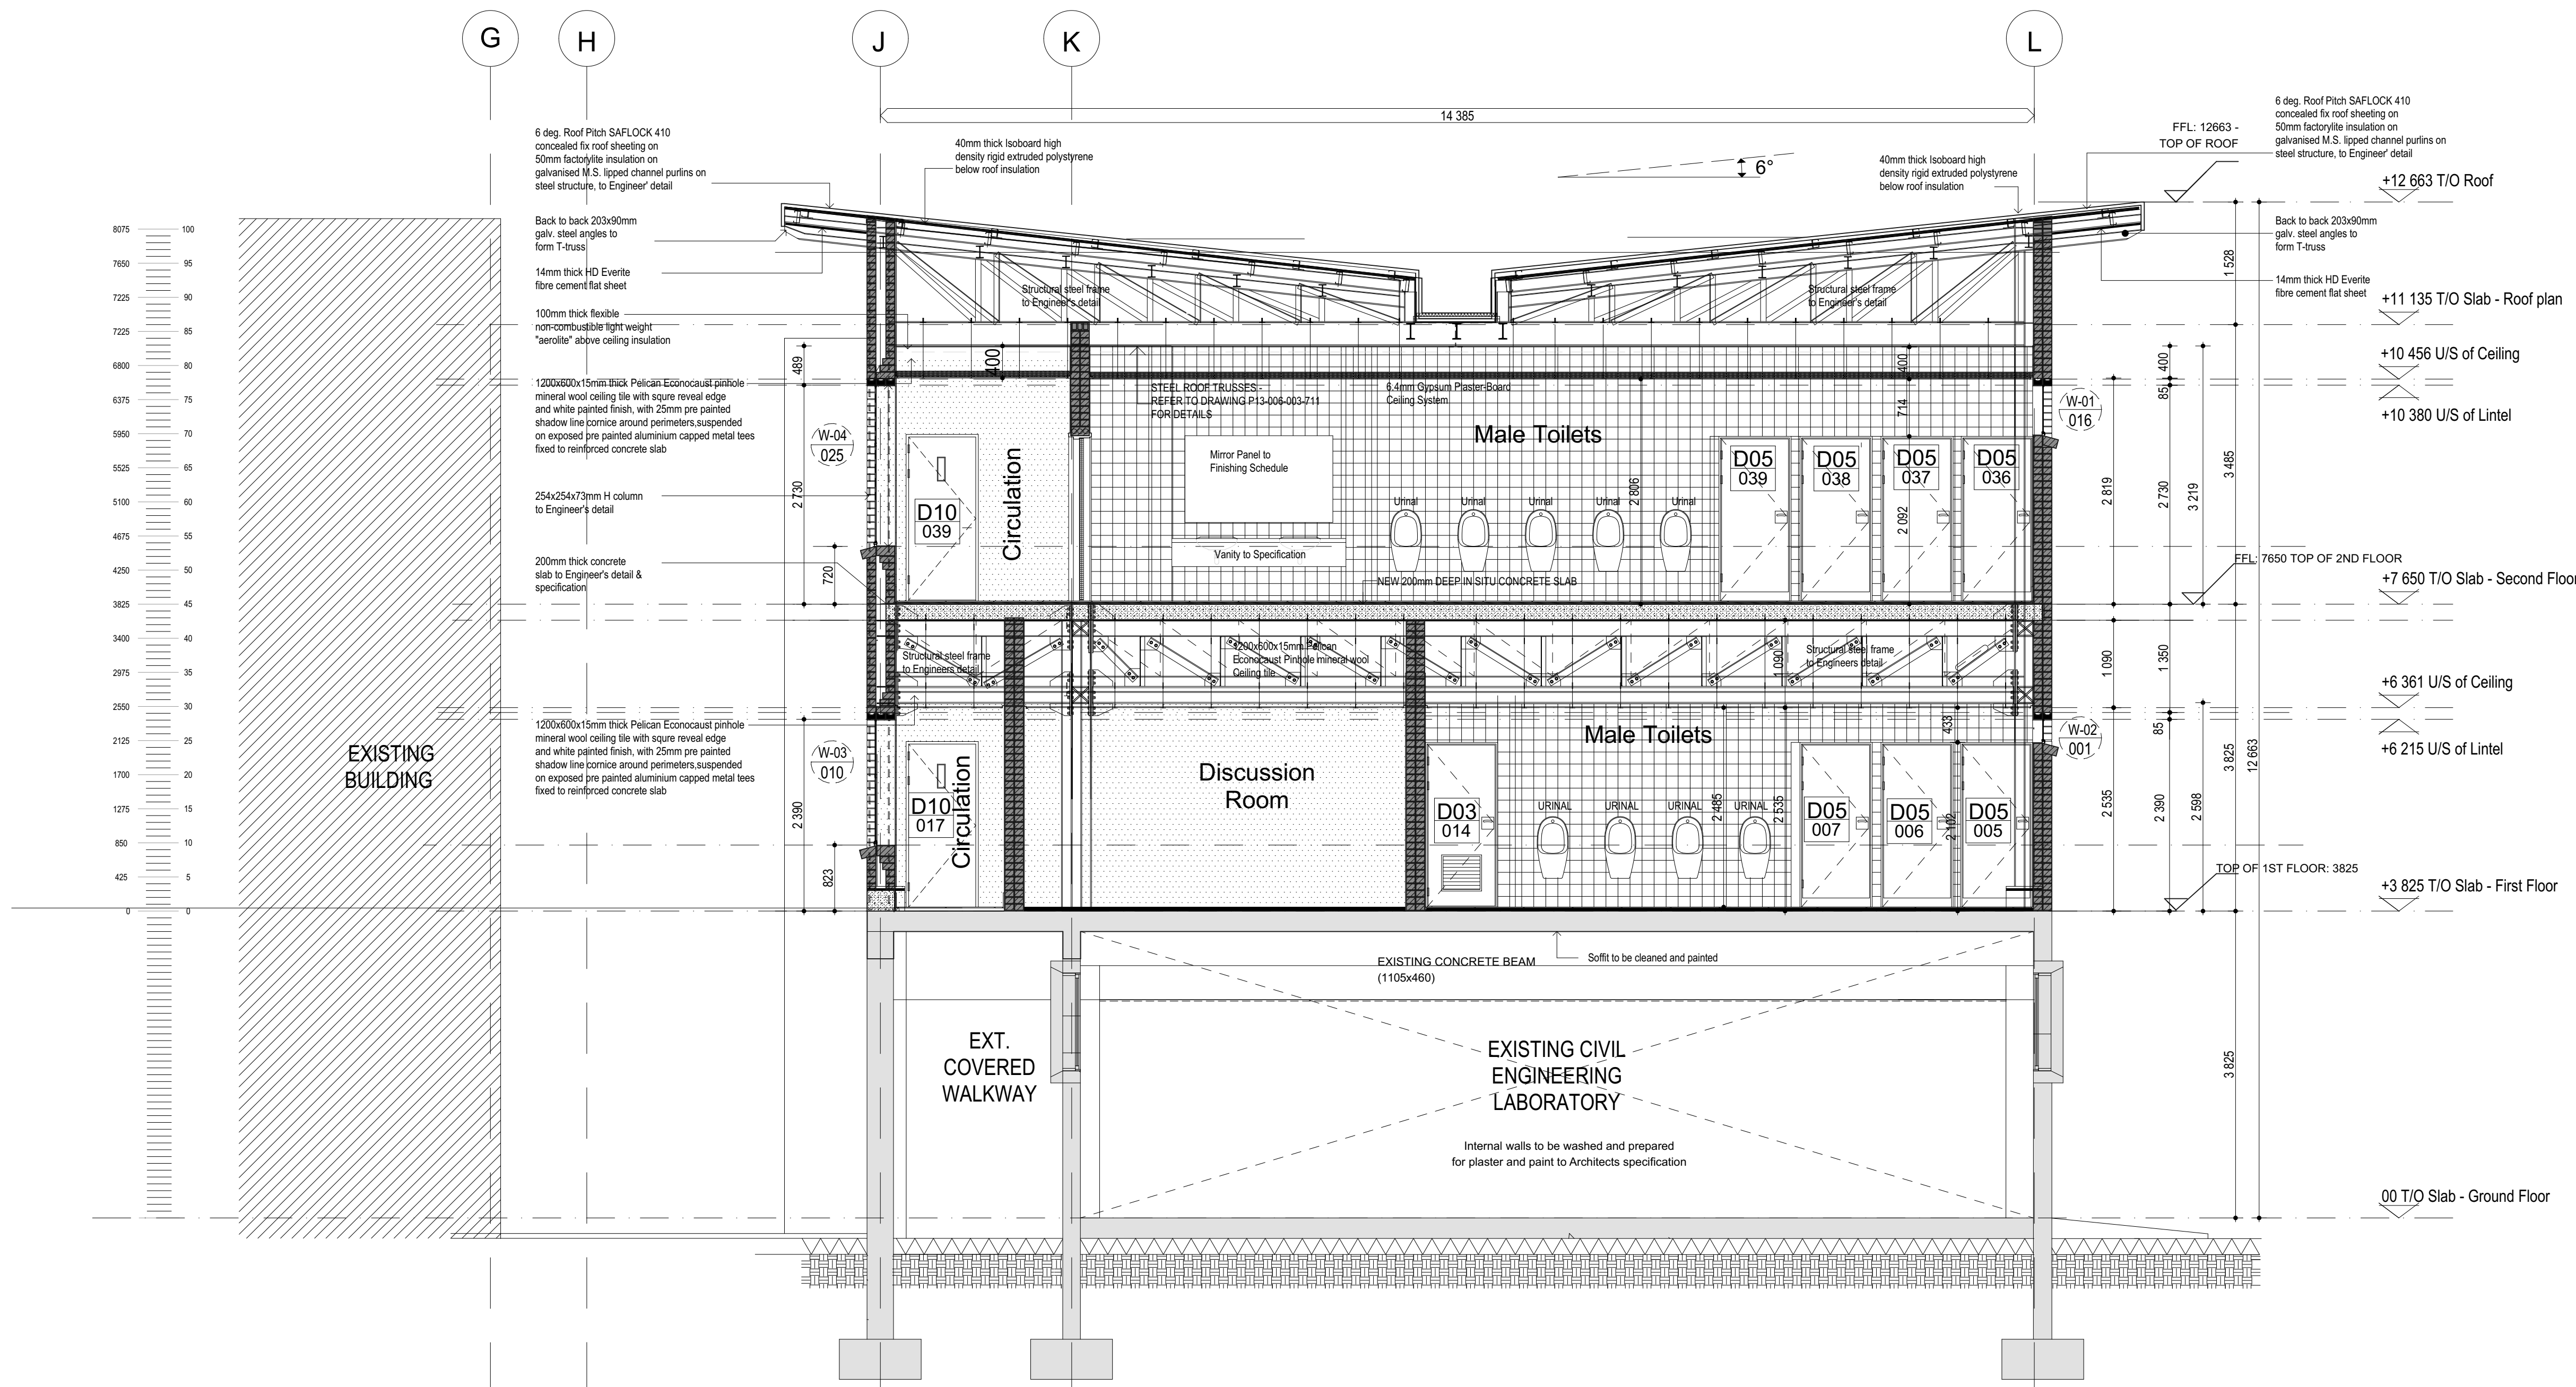

SECTION D-D  
SCALE 1:50

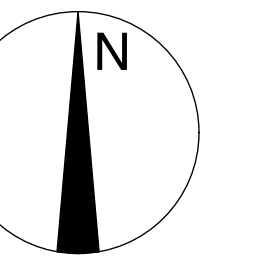

#### NOTES

##### GENERAL NOTES

- Quality of workmanship to comply with the SABS 9400 and National Building Regulations, and with the minimum standards specified in the standard particulars in the bill of quantities.
- Contractor to check all dimensions, levels, gradients and heights before commencing work. Any errors to be reported immediately to the architect/engineer.
- Contractor to identify and locate existing services on site and to protect these from damage for the duration of the works.
- Contractor to build to 250 micron PVC Deep Proof Course (whether or not these are shown on the drawings) to all external walls at each floor, beam and parapet level and to all windows and doors.
- Drawings are not to be scaled.
- Roof structure, and foundations to structural engineers detail.
- Retaining walls to structural engineers detail.

##### DRAINAGE AND PLUMBING

- All drainage and plumbing work and installation of sanitary fittings to comply with National Building Regulations and the Plumbing Institute of South Africa.
- Inspection eyes to be provided at all bends and junctions which are to be suitably marked at ground level.
- Minimum fall of drains to be 1:40.
- Approved manhole traps to be provided at all waste fittings.
- Inspection eyes at waste points to be accessible at all times.
- Pipes are to be sized as follows: WRO, sinks - diam 32mm; showers - diam 50mm; WCs, soil pipes, vents and stacks - diam 100mm.
- diam 100mm vent stack to be built into wall section.

##### ELECTRICAL INSTALLATIONS

- All electrical work to comply with National Building Regulations and SABS 0142.
- All work to be done under the supervision of an electrician registered with the Electrical Contractors Association (ECA).
- Main Distribution Board to be built in to wall (with isolator, earth leakage devices and circuit breakers).
- Electrical Cables to be PVC armoured copper cables (SABS 0150).

NO.	DATE	REVISION	SIGNED
T-1	28-08-2024	Issued for Tender	

#### CLIENT



#### ARCHITECT



#### PROJECT

PROPOSED EXTENSION TO THE  
LABORATORY & ENGINEERING  
BUILDING ON ERF 1418 BEDWORTH  
PARK FOR THE VAAL UNIVERSITY OF  
TECHNOLOGY - VANDERBIL PARK

#### DRAWING TITLE

#### SECTIONS C&D

#### ISSUE FOR TENDER ONLY

DRAWN	CHECKED	DATE	SCALE
M.J.D.	S.M.	28.08.2024	1:800

#### DRAWING NUMBER

PROJECT NUMBER	ISSUE NUMBER	STATUS	REV
2013/J005	AR/ENGB/301	T	1