



**NOTES**

**GENERAL COUNCIL NOTES**


1. Quality of workmanship to comply with the SABS 9402 and National Building Regulations, and with the minimum standards specified in the standard particulars in the bill of quantities.
2. Contractor to check all dimensions, levels, gradients and heights before commencing work. Any errors to be reported immediately to the architect/engineer.
3. Contractor to identify and locate existing services on site and to protect these from damage for the duration of the works.
4. Contractor to install 1250 micron PVC Drip Proof Course (whether or not these are shown on the drawings) to all external walls at each floor, beam and parapet level and to all windows and doors.
5. Changes are not to be made.
6. Roof structure, and foundations to structural engineers detail.
7. Relating walls to structural engineers detail.

**DRAINAGE AND PLUMBING**

1. All drainage and plumbing work and installation of sanitary fittings to comply with National Building Regulations and the Plumbing Institute of South Africa.
2. Inspection eyes to be provided at all bends and junctions which are to be readily marked at ground level.
3. Minimum fall of drains to be 1:60.
4. Approved metal traps to be provided at all waste fittings.
5. Inspection eyes at waste pipes to be accessible at all times.
6. Pipes are to be sized as follows: W/B, 40mm - diam 32mm; 40mm - diam 20mm; W/C, and pipes, vents and stacks - diam 100mm.
7. diam 100mm vent stack to be built into wall section.

**ELECTRICAL INSTALLATIONS**


1. All electrical work to comply with National Building Regulations and SABS 0142.
2. All work to be done under the supervision of an electrician registered with the Electrical Contractors Association (ECA).
3. Main Distribution Board to be built in to wall (with isolator, earth leakage devices and circuit breakers).
4. Electrical Cables to be PVC armoured copper cables (SABS 0150).

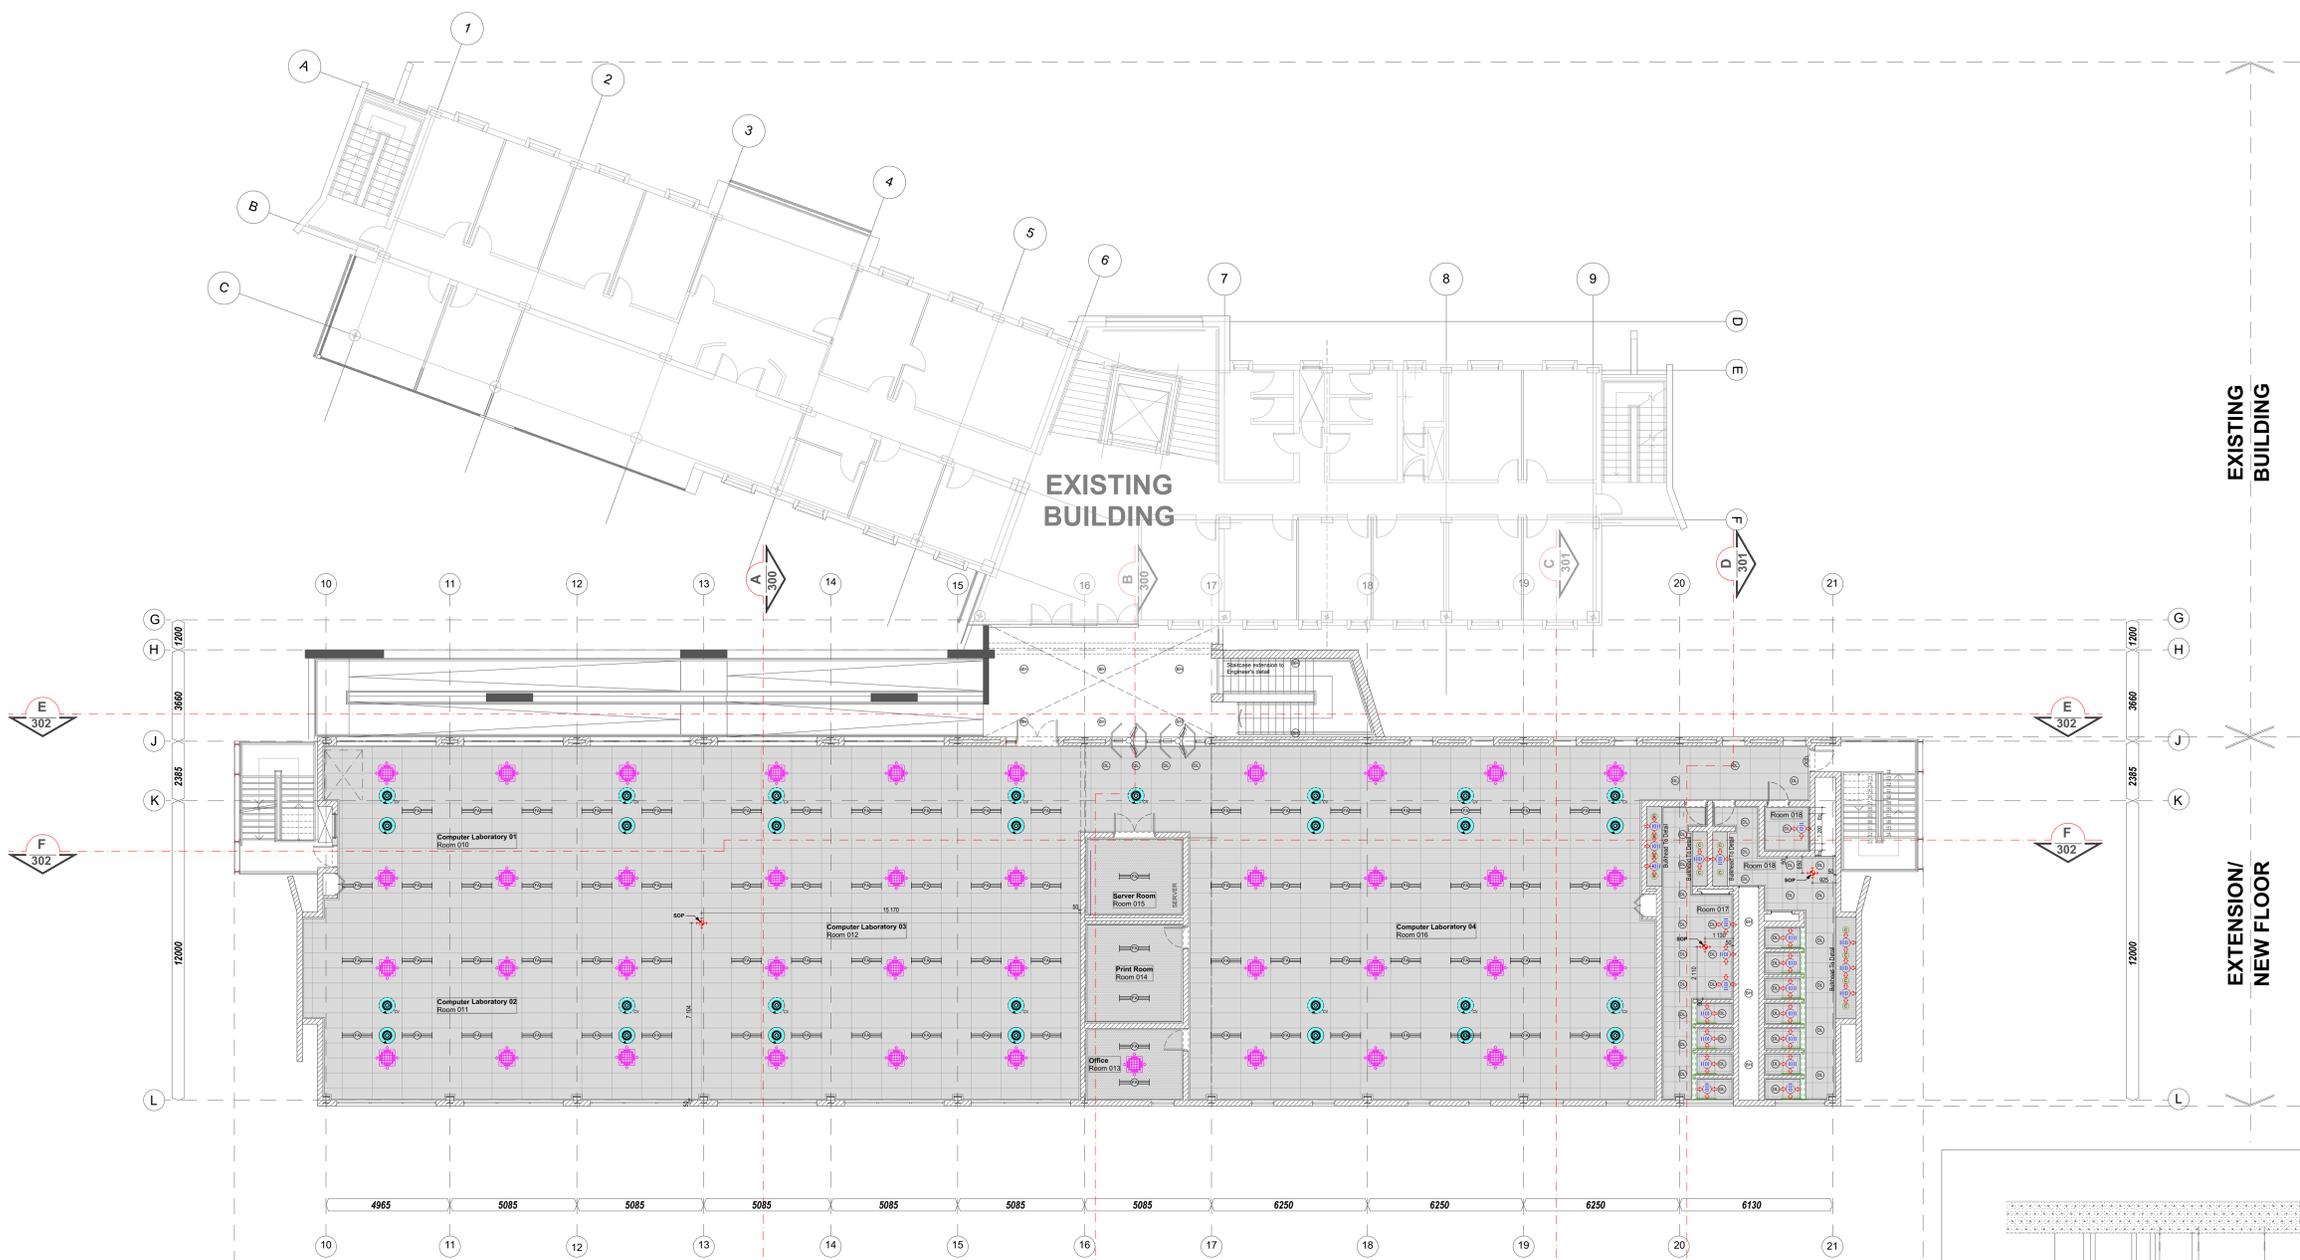

**NEW FLOOR**

**CEILING LEGEND**

- ARENGB Ceiling tiles - vinyl clad - insulated  
1200 x 600 x 15mm thick Pelican Econocast  
Prinole Mineral Wool Ceiling tile with square edges and white painted finish, suspended on exposed pre-painted aluminium capped metal tees.
- ARENGB Ceiling tiles - vinyl clad - insulated  
600 x 600 x 15mm thick Pelican Econocast Prinole Mineral Wool Ceiling tile with square edges and white painted finish, suspended on exposed pre-painted aluminium capped metal tees.
- ARENGB Bulkhead  
13.5mm flush plastered gypsum ceiling board on Bulkhead - Refer to bulkhead detail.

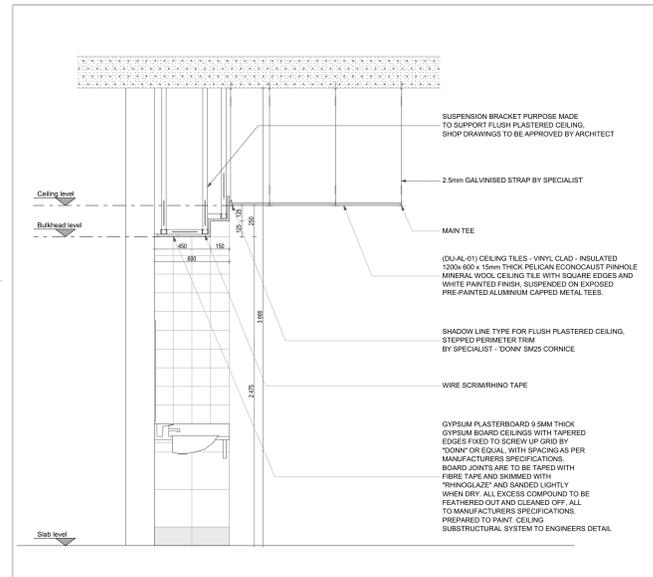

**TYPICAL ABLUTION BULKHEAD DETAIL**  
SCALE 1:20

**SECOND FLOOR PLAN - CEILING LAYOUT**  
SCALE 1:100

NO.	DATE	REVISION	SIGNED
T-1	28-08-2024	Issued for Tender	



**PROJECT**  
**PROPOSED EXTENSION TO THE LABORATORY & ENGINEERING BUILDING ON ERF 1418 BEDWORTH PARK FOR THE VAAL UNIVERSITY OF TECHNOLOGY - VANDERBIJLPARK**

**DRAWING TITLE**  
**SECOND FLOOR PLAN - CEILING LAYOUT**

**ISSUE FOR TENDER ONLY**

OWNER	DESIGNED	DWG	SCALE
M.J.D.	S.M.	28.08.2024	AS SHOWN

**DRAWING NUMBER**

PROJECT NUMBER	DRAWING NUMBER	DATE	REV
2013/J005	AR/ENGB/211	T	1